Variance Application: VAR 24-1192

LUHO Hearing Date:

November 20, 2024

Case Reviewer: Orlando Borrás



Development Services Department

Applicant: Terry Jr. and Selina Murphy Zoning: AS-1

Location: 8501 Lithia Pinecrest Road, Lithia, FL 33547; Folio: 93635.0200

Request Summary:

The applicant is requesting a variance to accommodate a ground mounted solar panel on the front side of the existing home on the property.

Requested Variance	ces:		
LDC Section:	LDC Requirement:	Variance:	Result:
6.01.03.I.11 6.01.01	Ground mounted solar panels may not project into the required front yard. A minimum 50-foot front yard setback is required in the AS-1 zoning district.	44-feet	6-foot front yard setback

Findings:	In June 2024, the applicant requested a building permit (HC-BLD-24-0061910). The Building Department noted that the application was not in compliance with the minimum setback requirements under the AS-1 zoning district.
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Zoning Administrator Sign Off:

Colleen Marshall Fri Nov 1 2024 12:35:13

DISCLAIMER:

The variance(s) listed above is based on the information provided in the application by the applicant. Additional variances may be needed after the site has applied for development permits. The granting of these variances does not obviate the applicant or property owner from attaining all additional required approvals including but not limited to: subdivision or site development approvals and building permit approvals.

APPLICATION NUMBER:	VAR 24-1192	
LUHO HEARING DATE:	November 20, 2024	Case Reviewer: Orlando Borrás
SURVEY/SITE PLAN		
		Can Attacked Dages
		See Attached Pages

PHOTOV **NT SYSTEM**

36 MODULES-GROUND MOUNTED -8501 LITHIA PINECREST RD, LITHIA, FL 33547, USA 14.220 KWDC, 10.440 KWAC

SYSTEM SUMMARY:

(N) 36 - CANADIAN SOLAR CS6R-395MS-HL (395W) MODULES
(N) 36 - ENPHASE ENERGY IQ8PLUS-72-2-US MICRO-INVERTERS
(N) JUNCTION BOX
(E) 200A MAIN SERVICE PANEL WITH (E) 200A MAIN BREAKER, (N) 60A FUSED AC DISCONNECT
(N) 60A NON-FUSED AC DISCONNECT
(N) 60A NON-FUSED AC DISCONNECT
(N) ENPHASE IQ COMBINER BOX 4

DAM AH CENSO"

MOUNTING STYLE: GROUND MOUNT

INTERCONNECTION METHOD : LINE SIDE TAP

DESIGN CRITERIA:

PV TYPE: - GROUND MOUNT SNOW LOAD : - 1 PSF WIND SPEED :- 130 MPH WIND EXPOSURE:- C

COORDINATE:- 27.852849, -82.136679 RISK CATEGORY:- I

FOUNDATION ONLY

GOVERNING CODES:

2023 8TH EDITION FLORIDA BUILDING CODE: RESIDENTIAL
2023 8TH EDITION FLORIDA BUILDING CODE: MECHANICAL
2023 8TH EDITION FLORIDA BUILDING CODE: FULLIMBING
2023 8TH EDITION FLORIDA BUILDING CODE: FUEL GAS
2023 8TH EDITION FLORIDA BUILDING CODE: ENERGY CONSERVATION
2023 8TH EDITION FLORIDA BUILDING CODE: ENERGY CONSERVATION 2023 8TH EDITION FLORIDA BUILDING CODE : EXISTING BUILI 2023 8TH EDITION FLORIDA BUILDING CODE : ACCESSIBILITY 2023 8TH EDITION FLORIDA BUILDING CODE : BUILDING 2020 NATIONAL ELECTRIC CODE (NEC) 2023 8TH EDITION FLORIDA FIRE PREVENTION CODE (NFPA) : EXISTING BUILDING

SHEET INDEX

PV-0 PV-2 SITE PLAN WITH GROUND PLAN GROUND PLAN WITH MODULES COVER SHEET

PV-3,3.1,3.2 ATTACHMENT DETAILS
PV-4
ELECTRICAL LINE DIAGF **ELECTRICAL LINE DIAGRAM WITH** VOLTAGE DROP CALCULATION

PV-4:1 PV-5 PV-6+ **EQUIPMENT SPEC SHEETS** WARNING LABELS & PLACARD

CONSTRUCTION NOTE:

NO LESS THAN #6 AWG AND NO GREATER THAN #6 AWG COPPER AND BONDED TO THE EXISTING GROUNDING ELECTRODE TO PROVIDE OR A INVERTER LOCATION CONSISTING OF A ULL ISTED 8 FT GROUND ROD WITH ACORN CLAMP. GROUNDING ELECTRODE CONDUCTORS SHALL BE THE PV MODULES ARE CONSIDERED NON-COMBUSTIBLE AND THIS SYSTEM IS A UTILITY GRID INTERACTIVE SYSTEM COMPLETE GROUND. AND BONDED TO AT THE SERVICE ENTRANCE. IF EXISTING SYSTEM IS INACCESSIBLE, OR INADEQUATE, OR IS ONLY METALLIC WATER PIPING. GROUNDING ELECTRODE SYSTEM OF EXISTING BUILDING MAY BE USED A GROUNDING ELECTRODE SYSTEM IN ACCORDANCE WITH NEC 690-47 A LADDER SHALL BE IN PLACE FOR INSPECTION A SUPPLEMENTAL GROUNDING ELECTRODE WILL BE USED AT THE AND 250-50 THROUGH 60 250-166 SHALL BE PROVIDED PER NEC

This limb has been elicifornically signed and ACCORDANCE WITH 250, 134 OR 250, 138(A) REGARDLESS OF VOLTA sealed by Saddam Annad FE using a Digital PROPER ACCESS AND WORKING CLEARANCE AROUND EXISTING A Signature and date Princet copies of this document. PROPOSED ELECTRICAL EQUIPMENT WILL BE PROVIDED are not considered signed and sealed and the PROPOSED SELECTRICAL EQUIPMENT WILL BE PROVIDED signature must be verified on any electronic copies ALL SIGNAGE WILL BE INSTALLED AS REQUIRED BY AND 2023 NEC. ACCORDANCE WITH 250.134 OR 250.138(A) REGARDLESS OF VOLTAGE ROPER ACCESS AND WORKING CLEARANCE AROUND EXISTING AND EXPOSED NON-CURRENT CARRYING METAL PARTS OF MODULE FRAMES EQUIPMENT, AND CONDUCTOR ENCLOSURES SHALL BE GROUNDED IN EACH MODULE WILL BE GROUNDED USING THE SUPPLIED GROUNDING POINTS IDENTIFIED BY THE MANUFACTURER.

PER NEC 240.24 HEIGHT OF INTEGRATED AC/DC DISCONNECT SHALL NOT EXCEED 6' 7"

THE GROUNDING ELECTRODE CONDUCTOR SHALL BE PROTECTED FROM PHYSICAL DAMAGE BETWEEN THE GROUNDING ELECTRODE AND THE PANEL OR INVERTER; IF SMALLER THAN #6 AWG COPPER WIRE PER NEC CONTINUOUS, EXCEPT FOR SPLICES OR JOINTS AT BUSBARS WITHIN LISTED EQUIPMENT PER NEC 250.64C 250-64B. THE GROUNDING ELECTRODE CONDUCTOR WILL BE

SURFACES. THE PV CONNECTION IN THE PANEL BOARD SHALL BE POSITIONED AT THE OPPOSITE (LOAD) END FROM THE INPUT FEEDER LOCATION OR ALL EXTERIOR CONDUIT SHALL BE PAINTED TO MATCH ADJACENT

ELECTRICAL NOTES BY SUBCONTRACTOR UPON COMMENCEMENT OF CONSTRUCTION. SITE CONDITIONS SHALL PREVAIL IF NO SCALE IS GIVEN. DRAWINGS ARE NOT NECESSARILY TO SCALE. ALL DIMENSIONS SHALL BE VERIFIED MAIN CIRCUIT LOCATION. NEC 690.64(B)(7)

ITS APPLICATION. ALL EQUIPMENT TO BE LISTED BY UL OR OTHER NRTL, AND LABELED FOR

ROUTED DIRECTLY TO, AND LOCATED AS CLOSE AS POSSIBLE TO THE NEAREST RIDGE, HIP, OR VALLEY. C WET ENVIRONMENT WIRING, CONDUIT, AND RACEWAYS MOUNTED ON ROOFTOPS SHALL BE ALL CONDUCTORS SHALL BE COPPER, RATED FOR 600 V AND 90 DEGREE

WORKING CLEARANCES AROUND ALL NEW AND EXISTING ELECTRICAL

EQUIPMENT SHALL COMPLY WITH NEC 110.26.

DRAWINGS INDICATE THE GENERAL ARRANGEMENT OF SYSTEMS.
CONTRACTOR SHALL FURNISH ALL NECESSARY OUTLETS, SUPPORTS,
FITTINGS AND ACCESSORIES TO FULFILL APPLICABLE CODES AND

SPECIFIED, THE CONTRACTOR SHALL SIZE THEM ACCORDINGLY ALL WIRE TERMINATIONS SHALL BE APPROPRIATELY LABELED AND WHERE SIZES OF JUNCTION BOXES, RACEWAYS, AND CONDUITS ARE NOT

AND MODULE SUPPORT RAIL, PER THE GROUNDING CLIP MODULE GROUNDING CLIPS TO BE INSTALLED BETWEEN MODULE FRAME

MANUFACTURER'S INSTRUCTION. MODULE SUPPORT RAIL TO BE BONDED TO CONTINUOUS COPPER E.G.C.

THE POLARITY OF THE GROUNDED CONDUCTORS IS NEGATIVE

PV-0

SCALE: NTS




INITIAL RELEASE 05/31/2024

UR RE/

DESCRIPTION

VERSION DATE

PV-0 **AERIAL PHOTO** SCALE: NTS

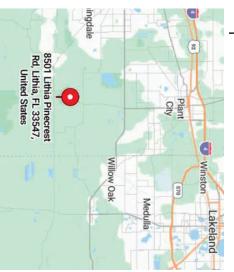

SHEET NUMBER 11" X 17"

ANSI B

COVER SHEET

SHEET NAME

VICINITY MAP

TERRANCE MURPHY	
8501 LITHIA PINECREST RD	,
LITHIA, FL 33547, USA	
NI NO - 223020777000005213	220

APN

AHJ: HILLSBOROUGH COUNTY


TERRORINGE MORE THE	
01 LITHIA PINECREST RD,	70
LITHIA, FL 33547, USA	ROJE
LITHIA, FL 33547, USA NO.: 223020ZZZ2000005212200U	CT NA
UTILITY: TECO	ME





CUSTOMER PROJECT ID: 7245 CA 92545
CSLB#: CVC57185 PHONE
NUMBER: 855-478-9091
www.currenthome.com


CURRENT HOME INC 7100 WEST FLORIDA AVE HEMET CURRENTHOME


24-1192

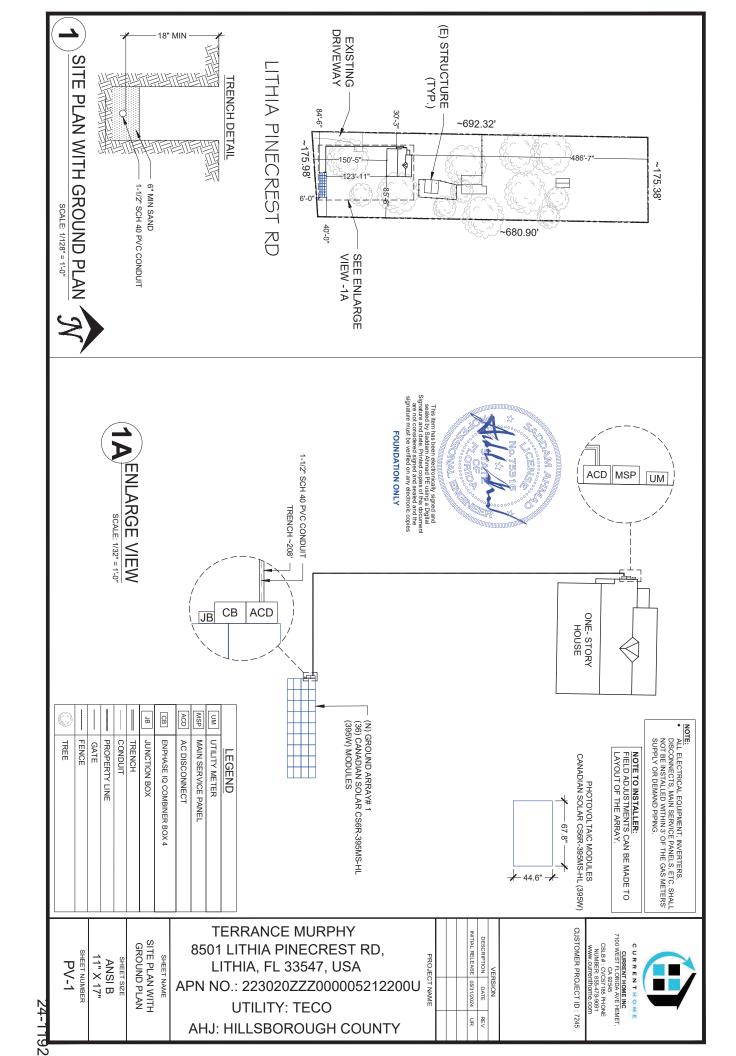

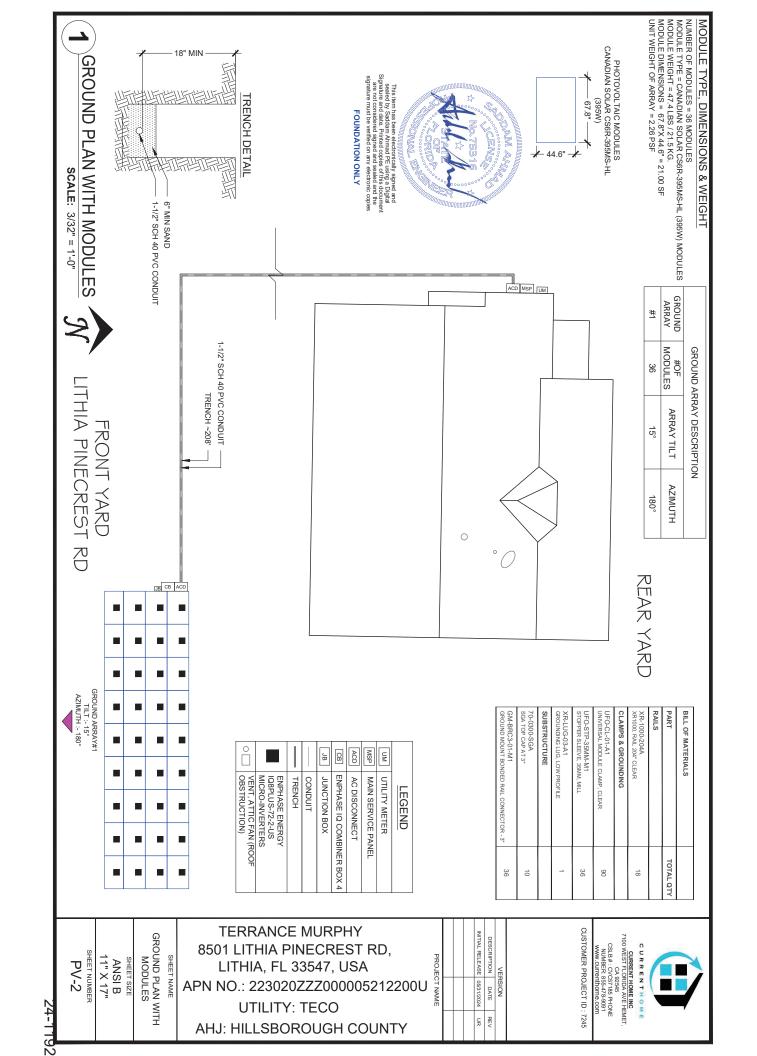

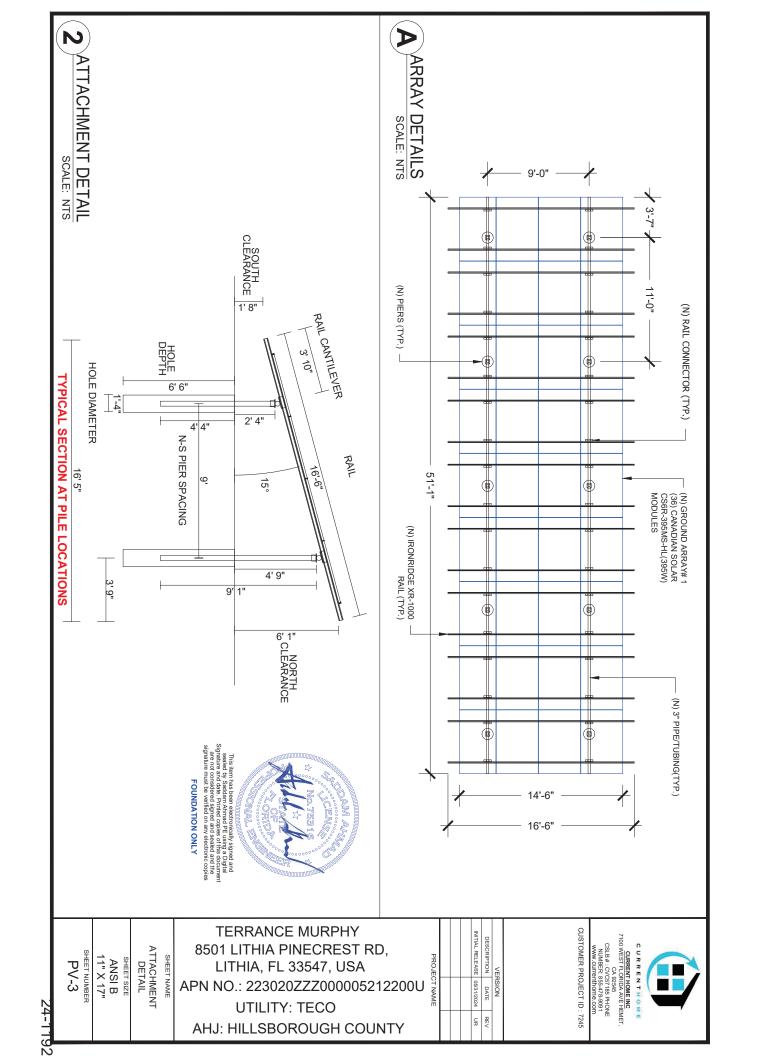


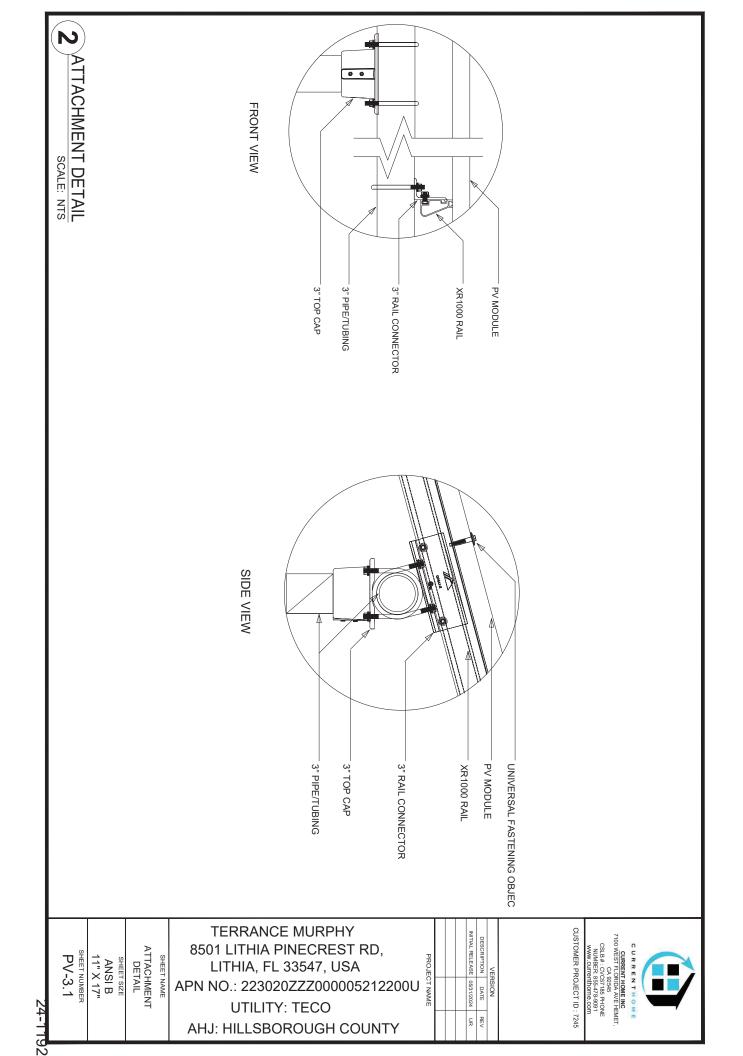

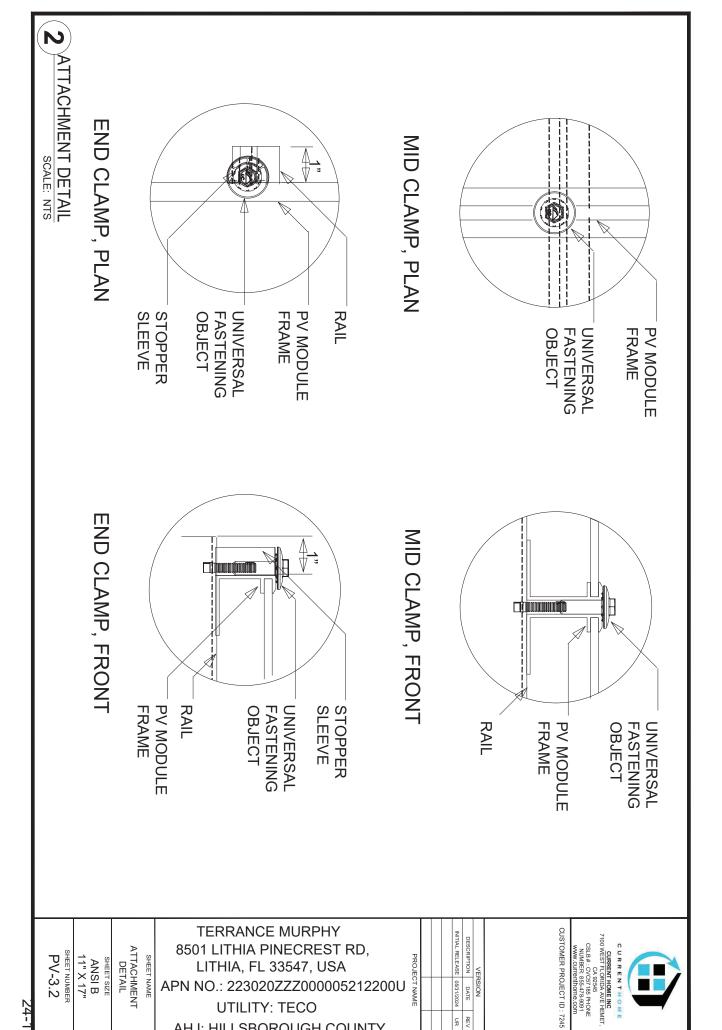

UR RE/

AHJ: HILLSBOROUGH COUNTY

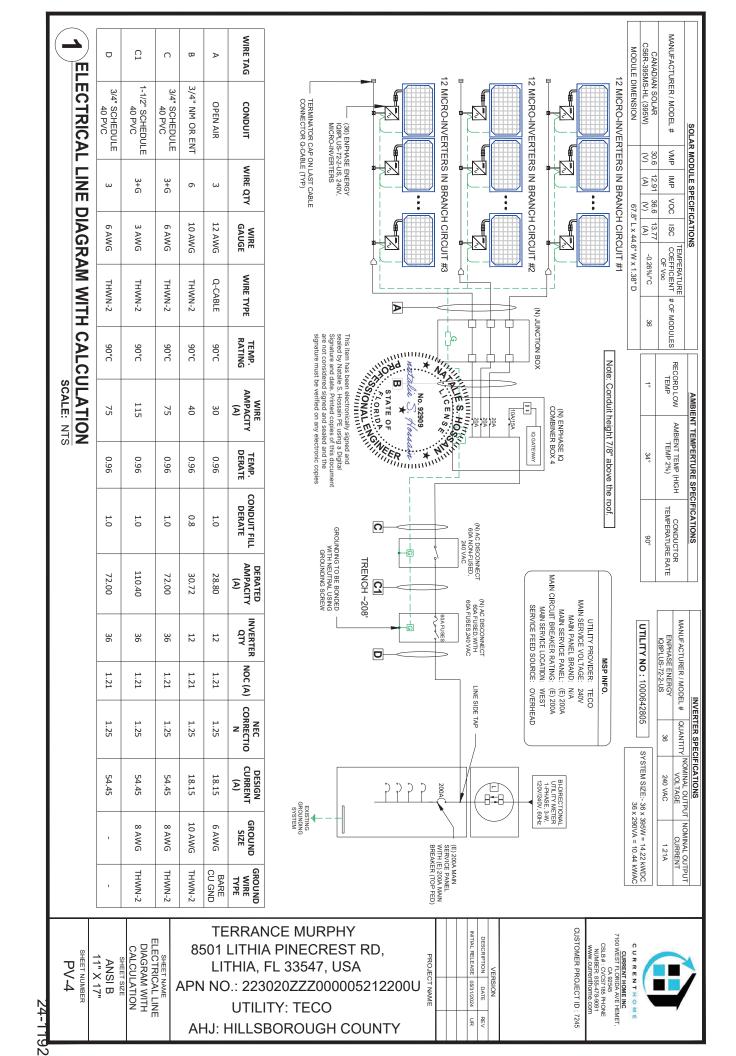

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VOLTAGE DROP CALCULATION
SCALE: NTS

	PASS THRU FUSED AC DISCONNECT TO INTERCONNECTION	PASS THRU NON-FUSED DISCONNECT TO FUSED AC DISCONNECT	PASS THRU COMBINER BOX TO NON-FUSED DISCONNECT	PASS THRU SOLAR J. BOX TO COMBINER BOX	BRANCH (MODULE) TO PASS THRU J. BOX	WIRE RUN	
	36	36	36	12	12	# OF INV	
2	240	240	240	240	240	V (VOLTS)	VOLTAGE
MAX VOLTAGE DROP: 1.98%	43.56	43.56	43.56	14.52	14.52	I (AMPS)	VOLTAGE DROP CALCULATIONS
DROP: 1.98%	5	208	5	5	15	L (FT)	ATIONS
	0.07%	1.49%	0.07%	0.06%	0.29%	VD (%)	
	6 AWG	3 AWG	6 AWG	10 AWG	12 AWG	WIRE SIZE*	
	3/4" SCHEDULE 40 PVC	1-1/2" SCHEDULE 40 PVC	3/4" SCHEDULE 40 PVC	3/4" NM OR ENT	FREE AIR	RACEWAY	
TERRANCE MURPH	IY			ALLINI	DES		

PROJE		INITIAL RELEASE	DESCRIPTION	VE	
PROJECT NAME		05/31/2024	DATE	VERSION	
		UR	REV		

CURRENT HOME INC
7100 WEST FLORIDA AVE HEMET,
CA 92545
CSLB # : CVCS7185 PHONE
NUMBER: 855-478-9091
www.currenthome.com CURRENTHOME

CUSTOMER PROJECT ID: 7245

8501 LITHIA PINECREST RD, LITHIA, FL 33547, USA APN NO.: 223020ZZZ000005212200U UTILITY: TECO AHJ: HILLSBOROUGH COUNTY

SHEET NUMBER PV-4.1

SHEET SIZE ANSI B 11" X 17"

VOLTAGE DROP CALCULATION

SHEET NAME

WARNING

ELECTRICAL SHOCK HAZARD

TERMINALS ON LINE AND LOAD SIDES MAY BE ENERGIZED IN THE OPEN POSITION

IABELLOCATION:
INVERTER(S), AC DISCONNECT(S), AC
COMBINER PANEL (IF APPLICABLE).
PER CODE(S): NIC 2020: NEC 706.15
(C)(4) & NEC 690.13(B)

PHOTOVOLTAIC

WARNING DUAL POWER SOURCE OND SOURCE IS PHOTOVOLTAIC SYSTEM

NEC 705.12(B)(3)(3) & NEC 690.59)

AC DISCONNECT

NEC 690.13(B)

AC DISCONNECT

LABEL LOCATION:
POINT OF INTERCONNECTION
PRODUCTION METER

- NOTES AND SPECIFICATIONS:

 SIGNS AND LABELS SHALL MEET THE REQUIREMENTS OF THE 2020 ARTICLE 110.21(B), UNLESS SPECIFIC INSTRUCTIONS ARE REQUIRED BY SECTION 690, OR IF REQUESTED BY THE
- SIGNS AND LABELS SHALL ADEQUATELY WARN OF HAZARDS
 USING EFFECTIVE WORDS, COLORS AND SYMBOLS.

 LABELS SHALL BE PERMANIENTLY AFFIXED TO THE
 EQUIPMENT OR WIRING METHOD AND SHALL NOT BE HAND
- LABEL SHALL BE OF SUFFICIENT DURABILITY TO WITHSTAND THE ENVIRONMENT INVOLVED.

 SIGNS AND LABELS SHALL COMPLY WITH ANSI Z535.4-2011.

 PRODUCT SAFETY SIGNS AND LABELS, UNLESS OTHERWISE
- DO NOT COVER EXISTING MANUFACTURER LABELS.

No. 92909 No. 92909 No. 92909 No. 970 Teacher No. 92909 No. 970 Teacher No. 9009 No. 970 Teacher No

This item has been electronically signed and sealed by Natalie S. Hossain PE using a Digital Signature and date. Printed copies of this document are not considered signed and sealed and the signature must be verified on any electronic copies

PHOTOVOLTAIC AC DISCONNECT

MAXIMUM AC OPERATING CURRENT: 43.56 AMPS NOMINAL OPERATING AC VOLTAGE: 240 VAC

INTERCONNECTION.
PER CODE(S): NEC 2020: 690.54 _ABEL LOCATION: AC DISCONNECT(S), PHOTOVOLTAIC SYSTEM POINT OF

PHOTOVOLTAIC POWER SOURCE


(PER CODE: NEC690.31(D)(2) LABEL LOCATION: EMT/CONDUIT RACEWAYS

MAIN PHOTOVOLTAIC SYSTEM DISCONNECT

LABEL LOCATION:
MAIN SERVICE DISCONNECT / UTILITY METER
(PER CODE: NEC 690.13(B))


RAPID SHUTDOWN FOR SOLAR PV SYSTEM

LABELLOCATION:
UTILITY SERVICE ENTRANCEMETER, (WITHIN 3)
INVERTERIDE DISCONNECT IF REQUIRED BY LOCAL AHJ,
OR OTHER LOCATIONS AS REQUIRED BY LOCAL AHJ. PER CODE(S): NEC 2020: 690.56(C)(2)

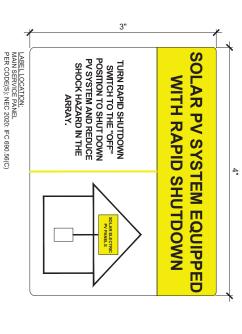

MULTIPLE SOURCES OF POWER CAUTION!

FOLLOWING SOURCES WITH DISCONNECTS LOCATED AS SHOWN POWER TO THIS BUILDING IS ALSO SUPPLIED FROM THE

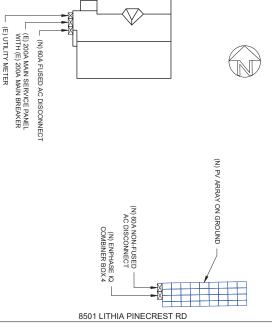

WARNING LABELS &

PLACARD

SHEET NAME

TERRANCE MURPHY 8501 LITHIA PINECREST RD, LITHIA, FL 33547, USA

APN NO.: 223020ZZZ000005212200U UTILITY: TECO AHJ: HILLSBOROUGH COUNTY

PROJECT NAME

INITIAL RELEASE 05/31/2024 DESCRIPTION DATE VERSION UR RE/

CUSTOMER PROJECT ID: 7245 CURRENT HOME INC 7100 WEST FLORIDA AVE HEMET CA 92545
CSLB#: CVC57185 PHONE
NUMBER: 855-478-9091
www.currenthome.com CURRENTHOME

24-1192

SHEET NUMBER 11" X 17"

ANSI B







HiKu6 (All-Black)

380 W ~ 405 W **ALL BLACK MONO PERC**

CS6R-380 | 385 | 390 | 395 | 400 | 405MS-HL

MORE POWER

25

Industry Leading Product Warranty on Materials and Workmanship*



Module power up to 405 W Module efficiency up to 20.7 %

Years

Linear Power Performance Warranty*



Comprehensive LID / LeTID mitigation



technology, up to 50% lower degradation



Better shading tolerance

ISO 9001:2015 / Quality management system
ISO 14001:2015 / Standards for environmental management system
ISO 45001: 2018 / International standards for occupational health & safety

MANAGEMENT SYSTEM CERTIFICATES*

"Subject to the terms and conditions contained in the applicable Canadian Solar Limited Varranty, Statement. Also this 25-year limited product warranty is available only for product warranty is available only for products installed and operating on residential rooftops in certain regions. Subsequent annual power degradation no more than 0.55% x year power degradation no more than 2%

IEC 61215 / IEC 61730 / CE CEC listed (US California) / FSEC (US Florida) UL 61730 / IEC 61701 / IEC 62716

PRODUCT CERTIFICATES*

scific certificates applicable to different module types and markets will vary, effore not all of the certifications listed herein will simultaneously apply to the you order or use. Please contact you focal Canadian Solar Sales representative in the specific certificates available for your Product and applicable in the regions

MORE RELIABLE







Heavy snow load up to 8100 Pa, wind load up to 5000 Pa*

solar photovoltalc modules, solar energy and battery storage solutions to customers. The company was recognized as the No. 1 module supplier for quality and performance/orite at alon the HS Module customer insight sun CSI SOLAR (USA) CO., LTD. is committed to providing high quality of premium-quality solar modules across the world.

CSI SOLAR (USA) CO., LTD.

1350 Treat Blvd. Suite 500, Walnut Creek, CA 94598, USA | www.csisolar.com/na | service.ca@csisolar.com



CS6R-380/385/390/395/400/405MS-HL ELECTRICAL DATA | STC*

MECHANICAL DATA

Opt. Operating Voltage (Vmp)30.0 V 30.2 V 30.4 V Opt. Operating Current (Imp) 12.69 A 12.77 A 12.84 Max. System Voltage Operating Temperature Open Circuit Voltage (Voc) Module Efficiency Short Circuit Current (Isc) 13.55 A 13.63 A 13.70 1000V (IEC/UL) 36.0 V 36.2 V 36.4 V -40°C ~ +85°C 19.5% 19.7% 20.0% 35.6 V 13.77 A

> Front Cover Dimensions Cell Arrangement

3.2 mm tempered glass with anti-ref-lective coating

(67.8 × 44.6 × 1.38 in) 108 [2 X (9 X 6)]

PROJECT NAME

22.4 kg (49.4 lbs) 1722 × 1134 × 35 mm

Frame

J-Box

IP68, 3 bypass diodes

Anodized aluminium alloy,

4 mm² (IEC), 12 AWG (UL)

Cable

Max. Series Fuse Rating	25 A
Application Classification	Class A
Power Tolerance	0~+10W
* Under Standard Test Conditions (ST rature of 25°C.	* Under Standard Test Conditions (STC) of irradiance of 1000 W/m 2 , spectrum AM 1.5 and rature of 25 $^\circ$ C.

ELECTRICAL DATA | NMOT*

Nominal Max. Power (Pmax) 284 W 288 W 291 W 295 W 299 W 303 W Opt. Operating Voltage (Vmp) 28.1 V 28.3 V 28.4 V 23.6 V 28.8 V 29.0 V Short Circuit Current (Isc) 10.91 A 10.98 A 11.05 A 11.11 A 11.17 A 11.23 A Nominal Module Operating Temperature 42 ± 3°C Open circuit voitage (voc) Opt. Operating Current (Imp) 10.12 A 10.19 A 10.26 A 10.33 A 10.39 A 10.45 A . Under Nominal Module Operating Temperature (NMOT), irradiance of $800\,W/m^2$ spectrum AM 1.5, inbient temperature 20°C , wind speed 1 m/s. 33.9 ¥ 34.1 ¥ 34.2 ¥ 34.4 ¥ 34.6 ¥ 34.7 ¥

*The specifications and key features contained in this datastheat may deviate slightly from our actual products due to the on-going innovation and product enhancement. CSI Solar Co., Ltd. reserves the right to make necessary adjustment to the information described herein at any time without further notice. Please be kindly advised that PV modules should be handled and installec by qualified people who have professional skills and please carefully read the safety and installation instructions before using

SPEC SHEETS

SHEET NAME

CSI SOLAR (USA) CO., LTD.

Aug 2022 | All rights reserved | PV Module Product Datasheet v1.1C25_F23_J1_NA

ENGINEERING DRAWING (mm)

CS6R-400MS-HL / I-V CURVES



Nominal Max. Power (Pmax) 380 W 385 W 390 W 395 W 400 W 405 W Cell Type 30.6 V 30.8 V 31.0 V Cell Arrand 12.91 A 12.99 A 13.07 A Dimension 20.2% 20.5% 20.7% 13.85 A 13.93 A Weight

	the same of the sa
Module Fire Performance	TYPE 2 (UL 61730 1000V) or CLASS C (IEC 61730)
Max. Series Fuse Rating	25 A
Application Classification	Class A
Power Tolerance	0~+10W

cell tempe-Per Container (40' HQ) 780 pieces
For detailed information, please contact your local Canadian Solar sales and technical representatives. Per Pallet Cable Length (Including Connector) Connector 1550 mm (61.0 in) (+) / 1100 mm (43.3 in) (-) 30 pieces T6, MC4, MC4-EVO2 or MC4-EVO2A

TEMPERATURE CHARACTERISTICS

Specification	Data
Temperature Coefficient (Pmax)	-0.34 % /°C
Temperature Coefficient (Voc)	-0.26 % /°C
Temperature Coefficient (Isc)	0.05 % / °C

PARTNER SECTION

TERRANCE MURPHY 8501 LITHIA PINECREST RD, LITHIA, FL 33547, USA

APN NO.: 223020ZZZ000005212200U UTILITY: TECO AHJ: HILLSBOROUGH COUNTY

CUSTOMER PROJECT ID: 7245 INITIAL RELEASE 05/31/2024 CURRENT HOME INC 7100 WEST FLORIDA AVE HEMET DESCRIPTION DATE CA 92545 CSLB#: CVC57185 PHONE NUMBER: 855-478-9091 www.currenthome.com CURRENTHOME VERSION UR RE/

SHEET NUMBER 11" X 17"

ANSI B SHEET SIZE







IQ8 and IQ8+ Microinverters

Easy to install

Lightweight and compact with plug-and-play connectors

High productivity and reliability Faster installation with simple two-wire cabling Power line communication (PLC) between components

Produce power even when the grid is down*

Our fewest IOB Microinvertees are the inclustry's first microgrid-forming, software-defined microinvertees that spill-phase power conversion appallity to convert IO power to AC power office of the semiconductor-based microinverter is our proprietary application-specific integrated circuit (ASIC), which neables the microinverter to poster in grid-ted or off-grid modes. This chip is built using advanced 55-mm technology with high-speed digital logs and has superfast response times to changing loads and grid events, alleviating constraints or battery stating for home energy systems.



Part of the Enphase Energy System,
IQ8 Series Microinverters integrate with the
IQ Battery, IQ Gateway, and the
Enphase App monitoring and analysis

(J

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IO8 Series Microinverters are UL Listed as PV rapid shutdown equipment and conform with various regulations, when installed according to the manufacturer's instructions.

Connect PV modules quickly and easily to IQ8 Series Microinverters using the included Q-DCC-2 adapter cable with plug-and-play MC4 connectors.

Class II double-insulated enclosure More than one million cumulative hours of

IQ8 Series Microinverters redefire reliability standards with more than one million cumulative hours of power-on testing, enabling an industry-leading limited werranty of up to 25 years,

Optimized for the latest high-powered PV modules

- Microgrid-forming Compliant with the latest advanced grid
- Remote automatic updates for the latest grid requirements
- Configurable to support a wide range of grid profiles
- Meets CA Rule 21 (UL 1741-SA) and IEEE 1547:2018 (UL 1741-SB)

Generations of Enphase microinverters (IG7 Series, IQ6 Series, and so on) in the same system.

IQ Microinverters ship with default settings that mee North America's IEEE 1547 interconnection standard ted by an Authority Having Jurisdiction (AHJ) y representative according to the IEEE 1547 nnection standard. An IQ Gateway is required to rese changes during installation.

IQ8SP-12A-DSH-00207-3.0-EN-US-2024-02-12

No enforced DC/AC ratio.
 Nominal voltage range can be extended beyond nominal in the control of the co

IQ8 and IQ8+ Microinverters

DATA SHEET

INPUT DATA (DC)	STINU	IO8-60-2-US	108PLUS-72-2-US
Commonly used module pairings ¹	8	235-350	235-440
Module compatibility	Ĺ	To meet compatibility, PV modules must be within maximum input DC voltage and maximum module _ listed below. Module compatibility can be cleacked at https://enphase.com/installers/microinverters/calculator.	nput DC voltage and maximum module I, listed below.
MPP7 voltage range	<	27-37	27-45
Operating range	<	16–48	16-58
Minimum/Maximum start voltage	<	22/48	22/58
Maximum input DC voltage	<	30	60
Maximum continuous input DC current	Þ	10	12
Maximum input DC short-circuit current	Þ	25	
Maximum module (I _{sc})	Þ	20	
Overvoltage class DC port	j	=	
DC port backfeed current	mA	0	
PV array configuration	1	Ungrounded array; no additional DC side protection required; AC side protection requires maximum 20 A per branch circuit	side protection requires maximum 20 A per branch circuit
OUTPUT DATA (AC)	STIND	108-60-2-US	108PLUS-72-2-US
Peak output power	VA	245	300
Maximum continuous output power	VA	240	290
Nominal grid voltage (L-L)	<	240, split-phase (L-L), 180°	(L-L), 180°
Minimum and Maximum grid voltage ²	<	211-264	
Maximum continuous output current	A	10	1.21
Nominal frequency	Hz	60	
Extended frequency range	Hz	47-68	
AC short-circuit fault current over three cycles	Arms	ю	
Maximum units per 20 A (L-L) branch circuit ³	1	16	13
Total harmonic distortion	%	^5	
Overvoltage class AC port	1	=	
AC port backfeed current	mA	30	
Power factor setting	1	1.0	
Grid-tied power factor (adjustable)	ı	0.85 leading 0.85 lagging	.85 lagging
Peakefficiency	%	97.7	
CEC weighted efficiency	%	97	
Nighttime power consumption	mW	23	25
MECHANICAL DATA			
Ambjent temperature range		-40°C to b0°C (-40°F to 140°F)	JT 10 (4UT)
Relative humidity range		4% to 100% (condensing)	ndensing)
DC connector type		MC4	
Dimensions (H × W × D)		212 mp (8.3 in) × 175 mm (6.9 in) × 30.2 mm (1.2 in)	e in) × 30.2 mm (1.2 in)
Weight		1.08 kg (2.38 lbs)	8 lbs)
Coolng		Natural convection-no fans	on-no fans
Approved for wet locations		Yes	
Pollution degree		PD3	
Enclosure		Class II double-insulated, corrosion-resistant polymeric enclosure	resistant polymeric enclosure
Environmental category/UV exposure rating	9	NEMA Type 6/Outdoor	Outdoor

IQ8SP-12A-DSH-00207-3.0-EN-US-2024-02-12

SPEC SHEETS

SHEET NAME

TERRANCE MURPHY 8501 LITHIA PINECREST RD, LITHIA, FL 33547, USA

APN NO.: 223020ZZZ000005212200U UTILITY: TECO AHJ: HILLSBOROUGH COUNTY

CURRENT HOME INC 7100 WEST FLORIDA AVE HEMET CURRENTHOME

CUSTOMER PROJECT ID: 7245 CA 92545
CSLB#: CVC57185 PHONE
NUMBER: 855-478-9091
www.currenthome.com

INITIAL RELEASE 05/31/2024

PROJECT NAME

DESCRIPTION

DATE

UR REV

VERSION

24-1192

PV-7 11" X 17"

ANSI B SHEET SIZE





X-IQ-AM1-240-4 X2-IQ-AM1-240-4 (IEEE 1547:2018) X-IQ-AM1-240-4C X2-IQ-AM1-240-4C (IEEE 1547:2018)

IQ Combiner 4/4C

The Exphase IQ Combiner 4/4C with IQ Gasteway and integrated LTE-Mi cell moden (included only with IQ Combiner IA) consolidates interconrection equipment rinta a single enclosure and strategiment of treatments of the inconverters and storage installations by providing a consistent, per-wired solution for residential applications. It offers up to four 2-pide input circuits and an Estion of Reservise busides assembly.



IQ Series Microinverters
The high-powered smart grid-ready IQ Series
Micronverters (IQ6, IQ7, and IQ8 Series)
dramatically simplify the installation process. IO System Controller 2
Provides microgrid intercornection device
(MID) functionality by automatically
detecting grid failures and seamlessly
transitioning the home energy system from
grid power to backup power.

O Bartery

All-in-one AC coupled storage system that is reliable, smart, simple, and safe, it provides backup capability, and installers can quickly design the right system size to meet the needs of both new and retrofit solar customers.

IQ Load Controller
Helps pricritize essential appliances
during a grid outage to optimize
energy consumption and prolong
battery life.





MON surface

defer to the https://enphase.com/installers/resources/warranty page for country specific warranty information.

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- Includes IQ Gateway for communication and control
- Includes Enphase Mobile Connect cellular modem (CELLMODEM-M1-06-SP-05), included only with IQ Combiner 4C
- Flexible networking supports Wi-Fi, Ethernet, or cellular
- Provides production metering and consumption monitoring

- Supports bottom, back and side conduit entry
- 80 A total PV or storage branch drcuits Up to four 2-pole branch circuits for 240 VAC plug-in breakers (not includød)

Fault current rating Busbar rating System voltage and frequency

KAIC

- UL Listed
 X2-IQ-AM1-240-4 and X2-IQ-AM1-240-4C comply with IEEE 1547:2018 (UL 1741-SB, 3rd Ed.)

Consumption monitoring CT (CT-200-SPLIT/CT-200-CLAMP)

IQ Gateway breaker

Maxinum total branch circuit breaker rating (input) Branch circuits (solar and storage) Maximum fuse/Circuit rating (output)

Production metering CT

- Includes solar shield to match IQBattery aesthetics and deflect heat
- Optional AC receptacle available for PLC bridge

Centered mounting brackets support single stud mounting

Rating

- DUITADIO NKI L-COTTINED NEMA TYPO 3R enclosure
- Five-year limited warranty
 Two-years labor relimbursement program coverage included for both the IG Combiner SKU's*

To learn more about Enphase offerings, visit enphase.com

US DATA SHEET

IQ Combiner 4/4C		
MODEL NUMBER	STINU	DESCRIPTION
IQ Combiner 4 (X-IQ-AMI-240-4, X2-IQ-AMI-240-4)	Ĺ	10 Combiner 4 with an 10 Gateway printed circuit board for integrated revenue-grade PV production meeting LMSR CE 20+0-5% and consumption monitoring (~25%), includes a sliver solar shalid to match the ID Battery and Color Service Combined and to deflect heat.
IQ Combiner 4C (X-IQ-AMI-240-4C, X2-IQ-AMI-240-4C)	1	IO Combine 4C with an IO Gateway printed circuit board for integrated revenue-grade PV production meeting (LMS) criz 20+ 0.5% and consumption mentioning (+.2.5%), includes Enhase Mobile Connect cellular modern (CLLM) DOBLE 4H-10-58-90.3), a play and -play included and position for systems up to 60 microinvertens. (Available in the IUS Canada, Maxico, Dearto Reco, and the IUS Virgin Islands, where there is adequate cellular service in the installation area). Includes a silver solar sheld to match the IO Battery and IO System Controller 2 and to deflect heast.
WHAT'S IN THE BOX	STIND	
IQ Gateway printed circuit board	Ĺ	Q Gateway is the platform for total energy management for comprehensive, remote maintenance, and management of the Enphase Energy System
Busbar	Ĺ	00 A busbar with support for 1 × 1Q Gateway breaker and 4 × 20 A breaker for installing 1Q 3 orios Microinverters and IQ Battery
IQ Gateway breaker	Þ	Circuit breaker, 2-pole, 10/15
Production CT	ı	Pre-wired revenue-grade solid-core CT, accurate up to +-0.5%
Consumption CT	j	Two consumption metering split core or clamp-type CTs, shipped with the box, accurate up to +-2.5%
Emphase Mobile Connect (only with IQ Combiner 4C)	1	4G-based LTE-M1 cellular modem (CELLMODEM-M1-06-SP-05) with a 5 year T-Mobile data plan
MICROINVERTERS, ACCESSORIES AND REPLACEMENT PARTS (not included; order separately)	STIND	
Supported microinverters	1	IQ6, IQ7, and IQ8. Do not mix IQ6/IQ7 Microinverters with IQ8
Enphase Communications Kit COMMS-CELLMODEN-M1-06 CELLMODEM-M1-06-59-05 CELLMODEM-M1-06-57-05	1	- includes COMMS-KIT-01 and CELLMODEM-M1-06-SP-05 with a 5-year Sprint data pan for Enphase sities street and the street of the street street of the street Sprint data plan - 46 based LTE-M1 cellu ar modem with a 5-year Sprint data plan - 46 based LTE-M1 cellu ar modem with a 5-year Af&T data plan
Circuit breakers (off-the-shelf)	Ĩ	Supports Eaton BR2xx. Swimmin 62xx and 6xxxxx 17502 1xx, Swinss breakers (x. may be 10, 15, 20, 30, 40, 50 or 60). Supports Eaton BR220B, BR230B and BR240B circuit breakers compatible with hold-down litt.
Circuit breakers (provided by Enphase)		BRK-10A-2-240V, BRK-15A-2-240V, BRK-20A-2P-240V, BRK-15A-2P-240V-B, and BRK-20A-2P-240V-B
XA-SOLARSHIELD-ES	ī	Replacement solar shield for IQ Combiner 4/4C
XA-ENV2-PCBA-4	1	IQ Gateway replacement printed circuit board (PCB) for IQ Combiner 4/4C
XA-FLUG-120-3		Accessory receptacle for power line carrier in IQ Combiner 4/4C (required for EPLC-01)
X-IQ-NA-HD-125A	1	Hold-down kit for Eaton circuit breaker with screws
ELECTRICAL SPECIFICATIONS	STINU	

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Up to four 2-pole Eaton BR, Siemens Q, or GE/ABBTHQL Series distributed generation (DG) breakers only (not included) 80 A of distributed generation/95 A with IQ Gateway breaker included A pair of 200 A split core or clamp-type current transformers 200 A solid core pre-installed and wired to IQ Gateway 10 A or 15 A rating GE/Siemens/Eaton included TERRANCE MURPHY 8501 LITHIA PINECREST RD, SPEC SHEETS SHEET NAME SHEET SIZE LITHIA, FL 33547, USA

90 64 125 10

APN NO.: 223020ZZZ000005212200U UTILITY: TECO AHJ: HILLSBOROUGH COUNTY

120/240 VAC, 60 Hz

80



CUSTOMER PROJECT ID: 7245

CURRENT HOME INC 7100 WEST FLORIDA AVE HEMET CA 92545
CSLB # : CVC57185 PHONE
NUMBER: 855-478-9091
www.currenthome.com

24-1192

SHEET NUMBER 11" X 17"

PV-8

ANSI B



XR Rail® Family

XR Rail[©] Family

Solar Is Not Always Sunny

ripping panels from a roof, and snowfalls weighing enough to buckle a panel frame. Over their lifetime, solar panels experience countless but the worst storms in 40 years. High winds capable of extreme weather events. Not just the worst storms in years,

spanning capability requires fewer roof attachments, reducing the preventing these results. They resist uplift, protect against buckling and safely and the amount of and efficiently transfer loads into the number of roof penetrations building structure. Their superior XR Rails® are the structural backbone

installation time.

Sloped roofs generate both vertical and lateral forces on mounting rails which can cause them to bend and twist. The curved shape of XR Rails[®] is specially designed to increase strength in both directions while residing the wisding. This unique feature ensures greater security during extreme weather and a longer system lifetime. Force-Stabilizing Curve

Compatible with Flat & Pitched Roofs

XR Rails® are compatible with FlashFoot® and other pitched roof attachments.

IronRidge® offers a range of tilt leg options for flat roof mounting applications.

Corrosion-Resistant Materials

All XR Rails® are made of 6000-series auminum alloy, then protected with an anodized finish. Anodizing prevents surface and structural corrosion, while also providing a more attractive appearance.

XR10

XR10 is a sleek, low-profile mounting rail, designed for regions with light or no snow. It achieves spans up to 6 feet, while remaining light and economical.

- 6' spanning capability
 Moderate load capability
 Clear & black anodized finish
 Internal splices available
- 10' spanning capability
 Heavy load capability
 Clear & black anodized finish
 Internal splices available

The XR Rail® Family offers the strength of a curved rail in three targeted sizes. Each size supports specific design loads, while minimizing material costs. Depending on your location, there is an XR Rail® to match.

XR100

XR100 is the ultimate residential mounting rail. It supports a range of wind and snow conditions, while also maxmizing spans up to 10 feet.



XR1000

XR1000 is a heavyweight among solar mounting rails. It's built to handle extreme climates and spans up to 12 feet for commercial applications.

- 12' spanning capability
 Extreme load capability
 Clear anodized finish
 Internal splices available

CUSTOMER PROJECT ID: 7245

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Rail Selection

The table below was prepared in compliance with applicable engineering codes and standards.* Values are based on the following criteria: ASCE 7-16, Gable Roof Flush Mount, Roof Zones 1 & Ze, Exposure B, Roof Slope of 8 to 20 degrees and Mean Building Height of 30 ft. Visit IronRidge.com for detailed certification letters.

Load	140	8	90								
(MPH) 90 20	6	8	90	90	40 20 90	80 40	90 80 80	60 60 60 60	90 60 00 00 00	90 80 80 80 80	80 80 90 80 80 80 80 80 80 80 80 80 80 80 80 80
XR10	XR10										
5; 4°											
6' XR100	XR100										
Rail Span											
10°	XR1000										
	J										

TERRANCE MURPHY 8501 LITHIA PINECREST RD, LITHIA, FL 33547, USA

UTILITY: TECO AHJ: HILLSBOROUGH COUNTY


APN NO.: 223020ZZZ000005212200U

SHEET NUMBER 11" X 17"

ANSI B

SPEC SHEETS

SHEET NAME

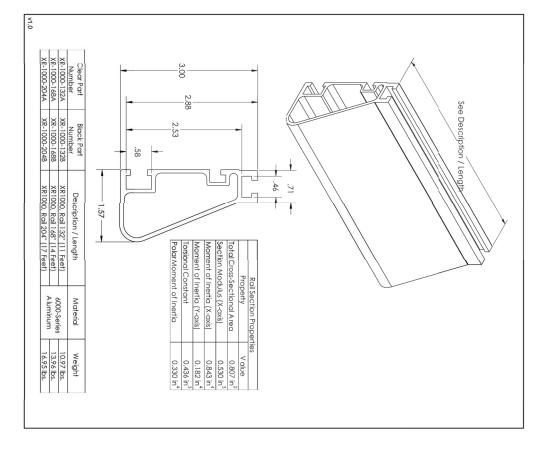

IRONRIDGE

XR1000® Rail

TERRANCE MURPHY 8501 LITHIA PINECREST RD, LITHIA, FL 33547, USA PV-10 SPEC SHEETS ANSI B 11" X 17" SHEET NAME SHEET SIZE APN NO.: 223020ZZZ000005212200U UTILITY: TECO

PROJECT NAME AHJ: HILLSBOROUGH COUNTY

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CUSTOMER PROJECT ID: 7245

CURRENT HOME INC.
7100 WEST FLORIDA AVE HEMET,
CA 92545
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Mount on all terrains, in no time.

Installation is simple with only a few structural components and no drilling, welding, or heavy machinery required. In addition, the system works with a variety of foundation options, including concrete piers and driven The IronRidge Ground Mount System combines our XR1000 rails with locally-sourced steel pipes, or mechanical tubing, to create a cost-effective structure capable of handling any site or terrain challenge.



0

Just a few simple components and no heavy equipment.

Simple Assembly

Engineered steel and aluminum components ensure durability.

Rugged Construction



Pre-stamped engineering letters available in most states. PE Certified

XR1000 Rails Rail Assembly

Top-Down Clamps

Under Clamps

Online tool generates engineering values and bill of materials. **Design Software**



20 Year Warranty

competitors. Twice the protection offered by

configuration options. Multiple foundation and array Flexible Architecture





Top Caps

Rail Connectors

Diagonal Braces

Cross Pipe & Piers

Connect vertical and cross

Attach Rail Assembly to

Optional Brace provides

additional support.

horizontal pipes.















Resources

spanning capabilities. Curved rails increase

Secure modules to rails and substructure.

attaching modules to rails. Alternative clamps for pre-

Wire Clips and End Caps provide a finished look.





Go from rough layout to fully engineered system. For free



NABCEP Certified Training

SPEC SHEETS

SHEET NAME

Earn free continuing education credits, while learning more about our systems. Go to ironridge.com/training

SHEET NUMBER 11" X 17" PV-11

ANSI B

TERRANCE MURPHY 8501 LITHIA PINECREST RD, LITHIA, FL 33547, USA

UTILITY: TECO AHJ: HILLSBOROUGH COUNTY

APN NO.: 223020ZZZ000005212200U

DESCRIPTION DATE

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CUSTOMER PROJECT ID: 7245

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CSLB#: CVC57185 PHONE
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Frequently Asked Questions

What is a "module type"?

this classification is to certify mounting systems without PV mcdule type, based on 4 construction parameters and 2 fire performance parameters. The purpose of needing to test it with every module. The new UL1703 standard introduces the concept of a

What roofing materials are covered?

All fire rated roofing materials are covered within this certification including composition shingle, clay and cemert tile, metal, and membrane roofs.

What if I have a Class C roof, but the jurisdiction now requires Class A or B?

Generally, older roots will typically be "grandfathered in", and will not require re-roofing. However, if 50% or more of the roofing material is replaced for the solar Where is the new fire rating requirement code listed? installation the code requirement will be enforced.

mounted photovoltaic systems shall have the same fire classification as the roof assembly required by Section 2012 IBC: 1509.7.2 Fire classification. Rooftop

Where is a Class A Fire Rating required?

has the most Class A and B roof fire rating requirements, due to wild fire concerns. The general requirement for roofing systems in the IBC refers to a Class C fire rating. Class A or B is required for areas such as Wildland Urban Interface areas (WUI) and for very high fire severify areas. Many of these areas are found throughout the western United States. California

Are standard mid clamps covered?

Mid clamps and end clamps are considered part of the PV "system", and are covered in the certification.

More Resources



Installation Manuals

Go to IronRidge.com

Visit our website for manuals that include UL 2703 Listing and Fire Rating Classification.

(F We offer complete engineering resources and pre-stamped certification letters. **Engineering Certification Letters**

Go to IronRidge.com

What attachments and flashings are deemed compatible with Class A?

flashing methods are acceptable from a fire rating Attachments and their respective flashings are not constituents of the rating at this time. All code-compliant

UL fire testing was performed with a gap of 5", which is considered worst case in the standard. Therefore, the rating is applicable to any module to roof gap.

What determines Fire Classification?

Class B - effective against moderate fire exposure Class C - effective against light fire exposure

The tilt mount system is rated for 1 degrees and up and

What mounting height is acceptable?

Am I required to install skirting to meet the fire

No, IronRidge achieved a Class A fire rating without any additional racking components.

to withstand fire exposure. Fire Classification refers to a fire-resistance rating system for roof covering materials based on their ability

Class A - effective against severe fire exposure

What if the roof covering is not Class A rated?

rating of the roof, whether Class A, B, or C. The IronRidge Class A rating will not diminish the fire

What tilts is the tilt mount system fire rated for?

any roof to module gap, or mounting height.

IRONRIDGE

Class A Fire Rating

CURRENT HOME INC 7100 WEST FLORIDA AVE HEMET

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CA 92545
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Background

classified for their ability to resist fire. All roofing products are tested and

fire rating as the original roof covering. and roof covering to be tested together as as part of the roof system. Specifically, this were expanded to include solar equipment a system to ensure they achieve the same equires the modules, mounting hardware Recently, these fire resistance standards

throughout the country in 2016. These new requirements are being adopted

ronRidge Certification

IronRidge was the first company to receive a Class A Fire Rating—the highest possible rating—from Intertek Group plc., a Nationally Recognized Testing Laboratory.

structural damage to the roof. evaluated the system's ability to resist roofs in accordance with the new UL 1703 lame spread, burning material and UL 2703 test standards. The testing Systems were tested on sloped and flat ronRidge Flush Mount and Tilt Mount

requirements for achieving a Class A Fire Rating on your next project. Refer to the table below to determine the



Burning Brand Test

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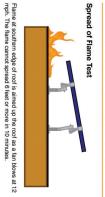
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VERSION

A burning wooden block is placed on module as a fan blows at 12 mph. Flame cannot be seen on underside of roof within 90 minutes.



ph. The flame cannot spread 6 feet or more in 10 minute	ame at southern edge of roof is aimed up the roof as a fan blows at 12		
ot spread 6 fe	ge of roof is		
eet or more	aimed up the		
n 10 minute	roof as a fi		
S.	an blows a		
	112	ľ	

Tilt Mount	Flush Mount	System	
≤ 6 Degrees	Any Slope	Roof Slope	
Type 1, 2, & 3	Type 1, 2, & 3	Module	
& 3 Class A	Class A	Fire Rating*	

TERRANCE MURPHY 8501 LITHIA PINECREST RD, LITHIA, FL 33547, USA APN NO.: 223020ZZZ000005212200U UTILITY: TECO

AHJ: HILLSBOROUGH COUNTY

SPEC SHEETS SHEET NUMBER 11" X 17" SHEET NAME ANSI B SHEET SIZE



Starling Madison Lofquist, Inc.

3600 E. University Dr. Suite 1400, Phoenix, Arizona 85034 tel: (602) 438-2500 fax: (602) 438-2505 ROC#291316 www.smleng.com

Hayward, CA 94545 28357 Industrial Boulevard

> Page 1 of 76 July 19, 2023

Attn: Mr. Sean McDonald, CEO, IronRidge Inc.

Subject: Ground Mounting System - Structural Analysis - 4 Module (XR1000)

applicable sections of the following Reference Documents: We have analyzed the subject ground mounted structure and determined that it is in compliance with the

Codes: ASCE/SEI 7-16 Min. Design Loads for Buildings & Other Structures
California Building Code, 2022 Edition
Other: AC428, Acceptance Criteria for Modular Framing Systems Used to Support PV Modules, dated Effective November 1, 2012 by ICC-ES

IronRidge Exhibit EX-0001 Aluminum Design Manual, 2020 Edition

in the attached Exhibit. of modules. The modules are clamped to the rails by the IronRidge Module Mounting Clamps as shown cantilever over and extend past the top and bottom cross pipes. There are typically two rails per column pipes are connected by proprietary IronRidge XR1000 Rails spanning up and down the slope which in the E-W direction by the cross pipes which cantilever over and extend past the end piers. The cross Exhibit EX-0001 for approved pipe geometry and material properties. The tops of the piers are connected The structure is a simple column (pier) and beam (cross pipe) system. The piers & cross pipes are ASTM A53 Grade B standard weight (schedule 40) steel pipes or Allied Mechanical Tubing. Please refer to

a braced frame. The effect of seismic loads (for all design categories A-F) have been determined to be less than the effect due to wind loads in all load conditions and combinations. beams. For lateral loads the system is either a cantilever structure or, when diagonal braces are provided Gravity loads are transferred to the piers and foundations by the rails and cross pipes acting as simple

The pier spacing in the N-S direction is 7'-6". The pier spacing in the E-W direction is selected from load tables determined by the structural design for the specified slope, wind load, and snow load. The governing criteria for the pier spacing is either the spanning capacity of the cross pipes or the cantilever capacity of the pier. Simplified Load Tables 1A-R & 2A-R are included herein for reference.

IronRidge.com. More comprehensive information covering all load combinations is available at the IronRidge website

Starling Madison Lofquist, Inc.

Consulting Structural and Forensic Engineers

Mr. Sean McDonald IronRidge

Ground Mounting System - Structural Analysis - 4 Module (XR1000)

Table 1B - MAXIMUM PIER SPACING (in)

160 mph Exposure C	150 mph Exposure C	140 mph Exposure C	130 mph Exposure C	120 mph Exposure C	110 mph Exposure C	105 mph Exposure C	100 mph Exposure C	95 mph Exposure C	90 mph Exposure C	2" Unbraced Pipe Frame Wind Speed & Exposure Category
10 0 48	0 10 20 30	10 20 30 40	10 20 30 50	20 20 30 30	0 10 20 30 40	0 10 20 30 50 50	10 20 30 40 50	0 10 20 30 50	0 10 20 30 40	Snow
87.75	75 78 86 86	90 90 77 77 88	70 74 88 89 97	72 73 88 99 F	73 73 73 73	116 107 92 92 87 80 80	75 88 94 95 75 87 87 87 87 87 87 87 87 87 87 87 87 87	89 98 172 88 88 75 88 98 12 88	131 114 97 91 83 75	(API
522225	76 88 89	22 23 25 25 28	2728895	7288855	115 106 106 107 108 108 108 108	8 7 8 8 9 8 8	2E88858	69 7 7 7 8 8 8 8 8 8 8 8 8 8 8 8 8 8 8 8	92 98 6 92 98 6	5
3882288	74 74 71 69	68 77 7 9 9	888468	68 77 8 9 9	2222888	67 7 68 7 8 8 8 7 6 7 7 6 8 7 8 7 8 7 8	68 72 78 89 10 10	104 104 79 69	116 107 87 88 87	10 F
3888888	2222	893222	882788	8827288	822825	23 28 28 28 28	882728895	8228825	7 7 8 8 9 10 13 7 7 8 8 9 2 10 13	ANELS 15
688888	6666	8 8 8 8 8 8	2222222	888888	22222	69 72 76 88 88 88	88888846	27988888	76 87 92 76 87 92	APPLICABLE TO PANELS UP TO 80in Slope (deg 0
24 24 27	27 27 27 27	888888	444444	344444	ব্রব্রব্র	88888888	3333333	22222222	666664	TO 80in) Slope (deg) 20 25
	20 20 20	222222	222222	888888	888888	4 4 4 4 4 4	444444	8888888	88888888	30
333333	7777	2888888	222222	322222	****	***	***	344444	444444	35
i i i i i i i i i i i i i i i i i i i	5555	377777	1000000	322222	222222	8888888	******	***	8666666	40
111111	12 12 12	4444	. ದೆ ದೆ ದೆ ದೆ ದೆ	3 3 3 3 3 3 3	222222	2222222	2222222			45

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Starling Madison Lofquist, Inc.

Consulting Structural and Forensic Engineers

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UTILITY: TECO AHJ: HILLSBOROUGH COUNTY

SHEET NUMBER 11" X 17"

ANSI B SHEET SIZE





Additional / Revised Information Sheet

Application Number: VA	R 24-1192	Office Use Only Received Date:	Received By:
must be submitted providi project size the cover lette	ng a summary of th r must list any new f	e changes and/or additiona	n that was previously submitted. A cover letter il information provided. If there is a change in tionally, the second page of this form must be ith this form.
Application Number:	R 24-1192	Applicant's Name:	larrod J. Fisk
			10/29/2024
Application Type:	_		_
	•		ce (PRS) Standard Rezoning (RZ)
☑ Variance (VAR)	Developme	nt of Regional Impact (DRI)	Major Modification (MM)
☐ Special Use (SU)	Conditional	Use (CU)	Other
Current Hearing Date (if ap	plicable):	0/2024	
Important Project Size	Change Informa	tion	
Changes to project size may	result in a new hear	ing date as all reviews will be	e subject to the established cut-off dates.
Will this revision add land t If "Yes" is checked on the ab		Yes No ou include all items marked w	with st on the last page.
Will this revision remove la If "Yes" is checked on the ab		? Yes No No No u include all items marked w	ith ⁺ on the last page.
Email this form		omittal items indicated or ngIntake-DSD@hcflgov.n	n the next page in pdf form to: et
	ents. All items shoul	ld be submitted in one emai	em should be submitted as a separate file il with application number (including prefix)
For additional help and	submittal questions	, please call (813) 277-1633	or email ZoningIntake-DSD@hcflgov.net.
I certify that changes descr will require an additional s			nmade to the submission. Any further changes
Elmo			10/29/24
- Emo	Signature		Date



Identification of Sensitive/Protected Information and Acknowledgement of Public Records

Pursuant to <u>Chapter 119 Florida Statutes</u>, all information submitted to Development Services is considered public record and open to inspection by the public. Certain information may be considered sensitive or protected information which may be excluded from this provision. Sensitive/protected information may include, but is not limited to, documents such as medical records, income tax returns, death certificates, bank statements, and documents containing social security numbers.

While all efforts will be taken to ensure the security of protected information, certain specified information, such as addresses of exempt parcels, may need to be disclosed as part of the public hearing process for select applications. If your application requires a public hearing and contains sensitive/protected information, please contact <u>Hillsborough County Development Services</u> to determine what information will need to be disclosed as part of the public hearing process.

Additionally, parcels exempt under <u>Florida Statutes §119.071(4)</u> will need to contact <u>Hillsborough County Development Services</u> to obtain a release of exempt parcel information.

Are you seeki to Chapter 11	그 그 그 그 그 그 그 그 그 그 그 그 그 그 그 그 그 그 그	d information submitted with your application pursuant
-	rm that the material submitted with application _ Includes sensitive and/or protected information.	VAR 24-1192
-	Type of information included and location	
	Does not include sensitive and/or protected inform	nation.
Please note: Sen	sitive/protected information will not be accepted/requested u	nless it is required for the processing of the application.
		determine if the applicant can be processed with the data vledge that any and all information in the submittal will
become public	c information if not required by law to be protected	d.
Signature:	Clarit of	
	(Must be signed by applicant or a	uthorized representative)
Intake Staff Sig	gnature:	Date:



Additional / Revised Information Sheet

Please indicate below which revised/additional items are being submitted with this form.

Inc	luded	Submittal Item
1		Cover Letter*+ If adding or removing land from the project site, the final list of folios must be included
2		Revised Application Form*+
3		Copy of Current Deed* Must be provided for any new folio(s) being added
4	\boxtimes	Affidavit to Authorize Agent* (If Applicable) Must be provided for any new folio(s) being added
5		Sunbiz Form* (If Applicable) Must be provided for any new folio(s) being added
6	X	Property Information Sheet*+
7		Legal Description of the Subject Site*+
8		Close Proximity Property Owners List*+
9		Site Plan*+ All changes on the site plan must be listed in detail in the Cover Letter.
10		Survey
11		Wet Zone Survey
12		General Development Plan
13		Project Description/Written Statement
14		Design Exception and Administrative Variance requests/approvals
15		Variance Criteria Response
16		Copy of Code Enforcement or Building Violation
17		Transportation Analysis
18		Sign-off form
19	\boxtimes	Other Documents (please describe):
		Narrative Property/ Applicant / Owner Information Form
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^{*}Required documents required when removing land from the project site. Other revised documents may be requested by the planner reviewing the application.

We are Current Home, Inc., a solar company operating in Florida. We received a request to install a ground-mounted solar system at the referenced property.

We submitted our application through the Hillsborough County Building Department portal and received an automatic approval for the installation permit (Permit Number: HC-BTR-24-0210278), which is a residential electrical trade permit. After completing the installation, we called for the required inspections and were notified that the wrong type of permit had been submitted. We were informed that a Residential Miscellaneous Permit needed to be applied for instead.

Upon submitting the correct permit, assigned Permit Number: HC-BLD-24-0061910, we encountered an issue regarding zoning compliance. The parcel is located in zoning district AS-1, which requires a front setback of 50 feet. According to Section 6.01.03.I.11 of the Land Development Code (LDC), ground-mounted solar panels may not project into the required front yard. We were advised to contact a zoning counselor for further assistance.

After consulting with the zoning counselor, we learned that if we cannot adjust the placement to meet the required setbacks—at least 44 feet from the front property line and 15 feet from the side property lines—we would need to apply for a variance.

The property contains several mature trees within the requested 44 feet. These trees cast significant shadows, which would limit the solar energy production necessary to effectively power the residence. Removing a considerable number of these trees would also impede the conservation of natural resources. Therefore, we recommend installing the solar system in a manner that avoids impacting the area where the trees are located.

The proposed installation is positioned 152 feet from the front of the house, with a height of 25 feet. This arrangement results in a variance of 102 feet from the required front yard setback, ultimately establishing a front yard of 108 feet.

Application No:	
rippiication	



Variance Criteria Response

 Explain how the alleged hardships or practical difficulties are unique and singular to the subject property and are not those suffered in common with other property similarly located?

The Solar system needs to be placed in a area where the full sunlight will power the system with not shades, and a roof mounted solar system can not be placed due to the fact that lots of trees are located aroung the residence, and to avoid the large shaded trees which would have affected the production tremendously we project the system to be mounted in the ground

Describe how the literal requirements of the Land Development Code (LDC) would deprive you of rights commonly enjoyed by other properties in the same district and area under the terms of the LDC.

The use of natural clean resource without having to cut or remove the trees around the house, those trees improve and maintain the quality of water, soil and air and to to remove pollutants from the air is well known. Trees also provide also provide shade and help lower temparature during summer and hot weather, that can also be enjoy for other properties

3. Explain how the variance, if allowed, will not substantially interfere with or injure the rights of others whose property would be affected by allowance of the variance.

This ground mounted solar system will no interfere or injure others, it is located within the property limits, and it is also consider clean and green energy, and in the case of a outage we can also help others giving a little bit of energy and encorage the homeowners next to the property to use clean and natural energy

4. Explain how the variance is in harmony with and serves the general intent and purpose of the LDC and the Comprehensive Plan (refer to Section 1.02.02 and 1.02.03 of the LDC for description of intent/purpose).

It is in armony with the use of natural resources, the use of clean or green energy reduces the greenhouses gas emissions and also this variance helps and it's according to the preservation of tress and other vegetation

5. Explain how the situation sought to be relieved by the variance does not result from an illegal act or result from the actions of the applicant, resulting in a self-imposed hardship.

It is not an illegal act if we want to approach the use of the available piece of land to install the solar system, avoiding the removal of a lot of elderly trees located around the house helping to preserve trees and vegetation by installing the solar system on the roof.

6. Explain how allowing the variance will result in substantial justice being done, considering both the public benefits intended to be secured by the LDC and the individual hardships that will be suffered by a failure to grant a variance.

The solar system is located where it will receive the source of clean energy substantially, allowing the use of it, and also preserve a lot of trees.



INSTRUMENT#: 2018308681, BK: 25960 PG: 820 PGS: 820 - 821 08/02/2018 at 12:31:42 PM, DOC TAX PD(F.S.201.02) \$2065.00 DEPUTY CLERK:TJORDAN Pat

Frank, Clerk of the Circuit Court Hillsborough County

Prepared by: Strategic Title, LLC Morgan Launikitis 6320 South Dale Mabry Hwy Tampa, FL 33611

File No.: RDL18-49789
This Deed is prepared pursuant to the issuance of Title Insurance

GENERAL WARRANTY DEED

Made this July 25, 2018. A.D. by Jose Ariel Contreras, a married man, whose address is: 2103 Johns Creek Circle, Johns Creek, GA 30097 hereinafter called the grantor, to Selina B. Murphy and Terry Murphy, Jr, wife and husband, whose post office address is: 8501 Lithia Pinecrest Rd, Valrico, FL 33594, hereinafter called the grantee:

(Whenever used herein the term "grantor" and "grantee" include all the parties to this instrument and the heirs, legal representatives and assigns of individuals, and the successors and assigns of corporations)

Witnesseth, that the grantor, for and in consideration of the sum of Ten Dollars (\$10.00) and other valuable considerations, receipt whereof is hereby acknowledged, hereby grants, bargains, sells, aliens, remises, releases, conveys and confirms unto the grantee, all that certain land situate in Hillsborough County, Florida, viz:

The West 1/4 of the NW 1/4 of the SW 1/4 of the SW 1/4 of Section 20, Township 30 South, Range 22 East, Hillsborough County, Florida, together with a perpetual non-exclusive easement for ingress and egress over and across the West 20 feet of the West 1/4 of the SW 1/4

Parcel ID No.: 093635-0200

Subject to all reservations, covenants, conditions, restrictions and easements of record and to all applicable zoning ordinances and/or restrictions imposed by governmental authorities, if any.

Said property is not the homestead of the Grantor(s) under the laws and constitution of the State of Florida in that neither Grantor(s) or any members of the household of Grantor(s) reside thereon.

Together with all the tenements, hereditaments and appurtenances thereto belonging or in anywise appertaining.

To Have and to Hold, the same in fee simple forever.

And the grantor hereby covenants with said grantee that the grantor is lawfully seized of said land in fee simple; that the grantor has good right and lawful authority to sell and convey said land; that the grantor hereby fully warrants the title to said land and will defend the same against the lawful claims of all persons whomsoever, and that said land is free of all encumbrances except taxes accruing subsequent to December 31, 2017.

Prepared by: Strategic Title, LLC Morgan Launikitis 6320 South Dale Mabry Hwy Tampa, FL 33611

incidental to the issuance of a title insurance policy

File No.: RDL18-49789

(SEAL)

In Witness Whereof, the said grantor has signed and sealed these presents the day and year first above written.

Signed and Sealed in Our Presence:

| State of Florida Georgia | State of F



Additional / Revised Information Sheet

Application Number: VA	R 24-1192	Office Use Only Received Date:	Received By:
must be submitted providi project size the cover lette	ng a summary of th r must list any new f	e changes and/or additiona	n that was previously submitted. A cover letter il information provided. If there is a change in tionally, the second page of this form must be ith this form.
Application Number:	R 24-1192	Applicant's Name:	larrod J. Fisk
			10/29/2024
Application Type:	_		_
	•		ce (PRS) Standard Rezoning (RZ)
☑ Variance (VAR)	Developme	nt of Regional Impact (DRI)	Major Modification (MM)
☐ Special Use (SU)	Conditional	Use (CU)	Other
Current Hearing Date (if ap	plicable):	0/2024	
Important Project Size	Change Informa	tion	
Changes to project size may	result in a new hear	ing date as all reviews will be	e subject to the established cut-off dates.
Will this revision add land t If "Yes" is checked on the ab		Yes No ou include all items marked w	with st on the last page.
Will this revision remove la If "Yes" is checked on the ab		? Yes No No No u include all items marked w	ith ⁺ on the last page.
Email this form		omittal items indicated or ngIntake-DSD@hcflgov.n	n the next page in pdf form to: et
	ents. All items shoul	ld be submitted in one emai	em should be submitted as a separate file il with application number (including prefix)
For additional help and	submittal questions	, please call (813) 277-1633	or email ZoningIntake-DSD@hcflgov.net.
I certify that changes descr will require an additional s			nmade to the submission. Any further changes
Elmo			10/29/24
- Emo	Signature		Date



Identification of Sensitive/Protected Information and Acknowledgement of Public Records

Pursuant to <u>Chapter 119 Florida Statutes</u>, all information submitted to Development Services is considered public record and open to inspection by the public. Certain information may be considered sensitive or protected information which may be excluded from this provision. Sensitive/protected information may include, but is not limited to, documents such as medical records, income tax returns, death certificates, bank statements, and documents containing social security numbers.

While all efforts will be taken to ensure the security of protected information, certain specified information, such as addresses of exempt parcels, may need to be disclosed as part of the public hearing process for select applications. If your application requires a public hearing and contains sensitive/protected information, please contact <u>Hillsborough County Development Services</u> to determine what information will need to be disclosed as part of the public hearing process.

Additionally, parcels exempt under <u>Florida Statutes §119.071(4)</u> will need to contact <u>Hillsborough County Development Services</u> to obtain a release of exempt parcel information.

Are you seek to Chapter 11	그 그 그 그 그 그 그 그 그 그 그 그 그 그 그 그 그 그 그	d information submitted with your application pursuant			
	irm that the material submitted with application _ Includes sensitive and/or protected information.	VAR 24-1192			
,	Type of information included and location				
×	Does not include sensitive and/or protected inform	nation.			
Please note: Sensitive/protected information will not be accepted/requested unless it is required for the processing of the application.					
		determine if the applicant can be processed with the data vledge that any and all information in the submittal will			
become public information if not required by law to be protected.					
Signature:					
	(Must be signed by applicant or a	uthorized representative)			
Intake Staff Si	gnature:	Date:			



Additional / Revised Information Sheet

Please indicate below which revised/additional items are being submitted with this form.

Inc	Included Submittal Item			
1		Cover Letter*+ If adding or removing land from the project site, the final list of folios must be included		
2		Revised Application Form*+		
3		Copy of Current Deed* Must be provided for any new folio(s) being added		
4	\boxtimes	Affidavit to Authorize Agent* (If Applicable) Must be provided for any new folio(s) being added		
5		Sunbiz Form* (If Applicable) Must be provided for any new folio(s) being added		
6	X	Property Information Sheet*+		
7		Legal Description of the Subject Site*+		
8		Close Proximity Property Owners List*+		
9		Site Plan*+ All changes on the site plan must be listed in detail in the Cover Letter.		
10		Survey		
11		Wet Zone Survey		
12		General Development Plan		
13		Project Description/Written Statement		
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Property/Applicant/Owner Information Form

	Official Use On	ıly	
Application No:		Intake Date:	
Hearing(s) and type: Date:	Type:	Receipt Number:	
Date:	Type:	Intake Staff Signature:	
0504 LITUUA DINIEGE	Property Inform		
dress: 8501 LITHIA PINECH	RESTRD City/S	tate/Zip: LITHIA, FL 33547	
N-RN-SEC: 20-30-22 Folio(s): 93635.0	200 Zoning: AS-1	Future Land Use: R-1 Property Size: 2.56	
	Property Owner Info		
me: MURPHY SELINA B	MURPHY TE	RRY JR Daytime Phone 813-758-5154	
lress: 8501 LITHIA PINECE	REST RD City/Star	te/Zip:LITHIA, FL 33547	
the4murphys@v	erizon.net	Fax Number	
	Applicant Inform	ation	
ne: Jarrod J. Fisk		Daytime Phone	
ress: 189 S Orange Ave suit	e 1530B City/Stat	om Fax Number	
<u>"jarrod.fisk@curre</u>	enthome.c	OM Fax Number	
	's Representative (if d	ifferent than above)	
ne: Karina Parra			
ress: 8600 Commodity Circle Suite	e 156 City/Stat	te/Zip:Orlando FL 32819	
ii: karina.parra@curr			
	Ond formore	Tax Number	
hereby swear or affirm that all the infor		ereby authorize the processing of this application	
rovided in the submitted application parent accurate, to the best of my knowledges.		d recognize that the final action taken on this etition shall be binding to the property as well as to	
thorize the representative listed above		e current and any future owners.	
act on my behalf on this application.			
Cand de	7	errance Murphy Selina B Murphy	
Jarsod Tisk	Sign	nature of the Owner(s) – (All parties on the deed must sign)	
Jarrod Mish		Terrance Murphy Selina B Murphy	